


PROGRESS WORKBOOK

CHIA TZE SHWEN (18026609)



PROBLEM STATEMENT

Food waste in the site area which is flocked with food haven and hotels are high and also the primary cause of pollution. Food is wasted during consumption as well as during the preparation and production of food, which contributes to 6% to 8% of greenhouse gas emissions. Food waste is a complex issue and comes from a range of sources: **production & harvest losses**, **hotel**, **restaurants and household waste**, **food waste and discards along supply chains**, **overstocked product displays**, **unsold and surplus food**. Statistics provided by SWCorp revealed that in 2021, food and plastic waste were the top two contributors to landfills. Besides that, 2022 government data showed Malaysians generate over 16,700 tonnes of waste daily, including 45% of food waste. Reducing food waste at all levels – consumer and domestic – could therefore have significant environment, social and economic benefits.

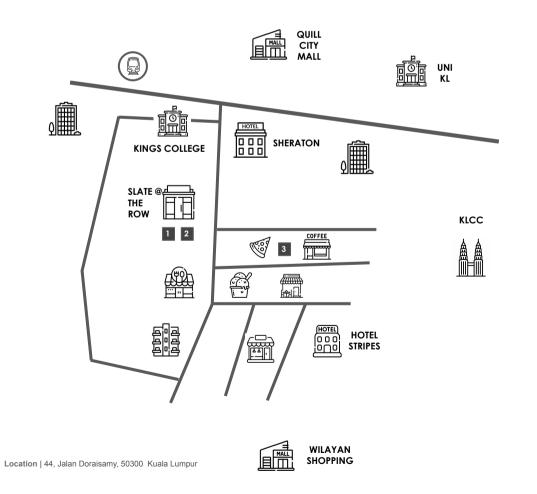

STRENGTHS 1 High concentration of businesses High activity and human node 2 Rich in culture & historical interest WEAKNESS / ISSUES Site is mostly flocked with upscales eateries Food waste from eateries Social and economic disparity OPPORTUNITY Encourage visits of visitors from different social and Support and integrate more locality and local flavors Community building and engagement Sustainable practices RIch in Culture & History (Nostalgic) THREATS Challenges in maintaining the rich city image Competitor

FINDINGS

SWCorp data shows trashpile averaged slightly over 200,000 tonnes a month since MCO 1.0, mostly from food and plastics



reported today.

Publish date: Thu, 11 Mar 2021, 12:01 PM

KUALA LUMPUR, March 11 — Malaysians have been generating over 200,000 tonnes in household waste nearly every month since the start of the first movement control order (MCO) in March last year, *The Star*

Citing internal data from the Solid Waste Management and Public Health Cleansing Corporation (SWCorp), the daily reported that food and plastic waste were the top two contributors to landfills.

A total of 201,574 tonnes in domestic waste was collected in March 2020.

In April the same year, households threw away another 165,697 tonnes' worth, followed by 197,919 tonnes in May and 214,326 tonnes in June.

Household waste dipped slightly in July to 212,036 tonnes but rose again in August to 215,224 tonnes, and totalled 207,457 for Sentember

Another 205,134 tonnes of domestic waste was collected in October, followed by a total of 207,700 tonnes in November and 211,990 tonnes in December 2020.



Malaysians Dispose Enough Edible Food To Feed An Estimate Of 2 Million People Every Day, Says NGO


Almost 24% of food waste is classified as edible meaning this can feed almost two million people daily, higher than the population of Kuala Lumpur.







SOURCE OF FOOD WASTE IN CHOW KIT AREA

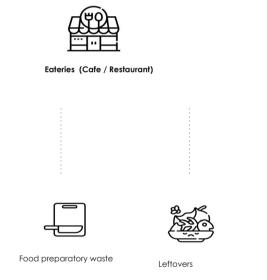

"45% wastage of restaurant food occurs at the preparatory stage, 21% due to improper storage, and 34% at the consumption stage."



Colleges / Universities



Plate Waste

Food overproduction & expiration

"Kitchen culture and staff behavior such as

over-preparation of food, improper ingredient

storage and failure to use food scraps and

trimmings contribute to food waste."

"Hotel buffets are often the main



Buffet Leftovers

source of food waste as

unconsumed leftovers are

eventually thrown away."





Leftovers



Overstocked product display



Unsold food



Plastics & packaging

"Most distributors are unable to clear their stocks before the next shipment arrives and inventory space is finite. Also, most unsold goods are thrown away as it is illegal to sell anything passed its expiry date, it's common practice that around 5% of stock going to waste regularly."

CLIENT




THE MISSION

To help local names gain larger audi ence in domestic entrepreneurial scene.

- To help eliminate costly listing fee for small local players.
- Do away the perception that Malaysian made food & drinks are of low quality.
- Rekindle the nostalgia of old school shopping idea.
- Be more sustainable sensible ay that better caters to modern needs.

THE PRODUCTS

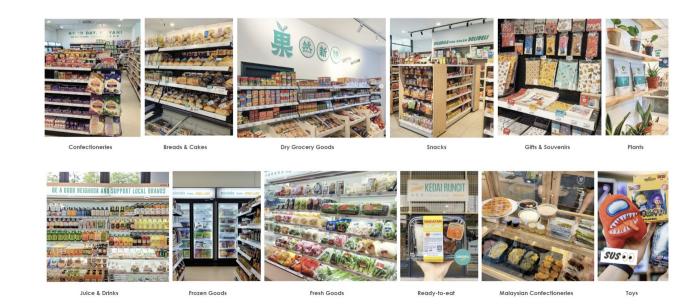





CLIENT

01


Bila Bila Mart

"KEDAI RUNCIT REIMAGINED"

A Malaysian covenience grocer, inspired by Malaysian's culture, heritage and food.

SUPPORTILOCAL

Housing Malaysian-produced groceries, Bila-Bila Mart is a proud supporter of homegrown Malaysian brands. The #KedaiRuncitModern

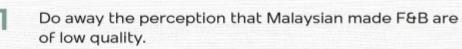

Rekindle the nostalgia of old school shopping.

3

3 Be more sustainable that better caters to modern needs.

03

03

Mission

Vision

Participate in the success of local brands.

Affordable & locally driven product range.

Grocery like in the good old days.

04

Founder

Bila-Bila mart is founded by Lee Hui Jing and her husband who has expertise in the field of property.

bilabila



Interior

Refreshed contemporary style with brand identity throughout the store that carries the expressions of Malaysian culture and identity.

BRAND IDENTITY THROUGHOUT THE STORE

Grabbing attention and engaging customers creates memorable brand expression

Wordplay of Chinese words Graphic inspired by Malaysian hand sign Word play of Chinese phrase Graphic inspired by vintage chinese poster Informality create a sense of camaraderie

























Malaysian Slang 'Lah'

Puns & Humors

Graphic inspired by childhood snacks Malay phrase that encourage people to drink water

Expressions of Malaysian culture and identity

THE MARKETPLACE TIES

Ties: a thing that unites or links people, connect

"Sense of being together as one with a crowd, even in the absence of a relationship between each individual"

The Marketplace Ties is a reinterpretation of a traditional marketplace while tying the brand culture with local culture, traditional with modern, the past with the future. The valued moments in a marketplace are manifested into the space through veritable maze of alleys and ethos of open-armed hospitality. Capturing the pulse and texture of traditional marketplace, tying together people and products into one community.

AIM + OBJ

To revisit and reinterpret traditional marketplace ideas started in the past by conveying an atmosphere of nostalgia through spatial arrangement and the use of materiality, detailing and technology.

How can we be modern and futuristic without disregarding local tradition?

CONCEPT

MARKETPLACE ELEMENTS

ALLEYWAYS AISLES



STREET BOOTHS





MARKET STRUCTURES




CANOPIES



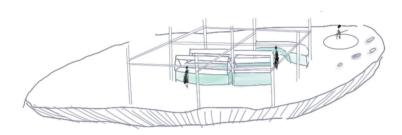

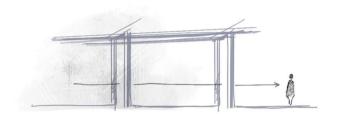

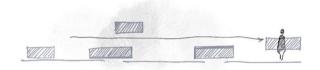

Intertwined

Labile changeable; easily altered

Grids

Liminal transition from place to place





















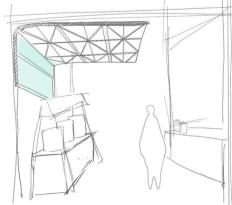

REINTERPRETING ELEMENTS OF TRADITIONAL MARKETPLACE



MOODBOARD

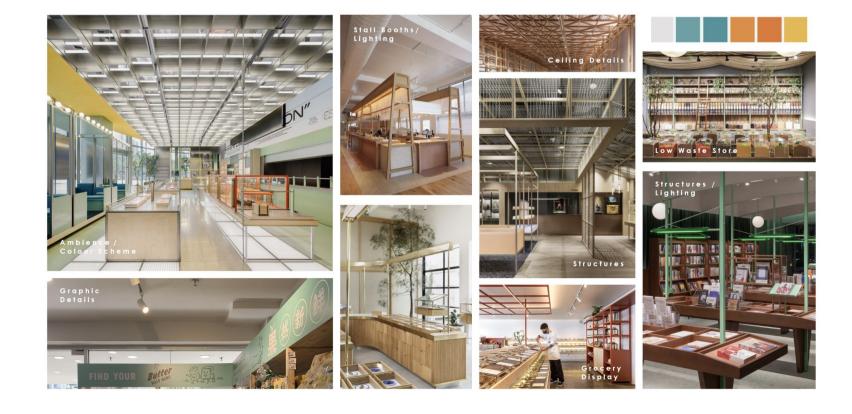

Experience + THE TIES Maze of alleyways + Open-armed hospitality Journey - Intertwined - Labile - Memory - Microcosmo - Sense of place

THE MARKETPLACE TIES

CONCEPT + APPROACH

SPACE PROGRAM

PROGRAM OUTLINE



Low Waste Grocery Store

Refillery without unnecessary packaging



Zero-Waste
Cooking Class

Providing cooking recipes using ingredients you can buy in bulks, use across several meals, recipes that won't require obscure ingredients that you might not use again.

Making fruit jams and jellies



Compost & Bio-enzyme
Workshop

Making compost & bio-enzyme using leftover fruit and veggie scraps after the zero-waste cooking class.



Veggie Garden

Growing several types of local veggies in-house. The nutrient-dense compost enriches soil and promotes veggie plant growth.



Smoothie Bar & Bakery

Providing an opportunity for grocers to use item in baked goods, smoothies, fruit and vegetable trays before they go bad

Turn something that might be otherwise thrown away into a high-margin product

PROGRAM APPROACH



Experiencing

Experiencing nostalgic marketplace



Processing

Processing ingredients into valuable meal



Cultivation

Cultivating skills in composting food waste



Harvesting

Harvesting veggies and herbs for use



Consumption

Consumption of grocers into smoothies, juices, & baked goods

1 LOW WASTE GROCERY STORE

How it works

RELEVANCE TO BRAND AND ISSUE



Bila-Bila Mart carries the mission to operate more sustainably and sensible. Food waste and packaging waste could be reduced/eliminated.

WHY?



Eliminate plastic

& packaging





Eliminate food waste

Promote locally sourced products

Smart shopping cart with weight sensors



Fill up Mason Jars/ Paper bags

FINDINGS

The goal of zero waste grocery stores

The goal is simple: to eliminate all packaging and food waste from the stores' operations. The businesses do not use plastic bags to round up customers' groceries, but instead require customers to bring their own reusable bags into the store and collect the items they need. Of course, not everyone that enters the store is prepared for this, so most leave out bags made of paper or other reusable material for the customer to use if needed.

These stores, more often than not, feature a warehouse or market-style layout in which most items are not wrapped in individual packaging and are bought in bulk. This eliminates a substantial amount of excess plastic waste.

Food waste is also another angle from which these zero waste stores aim to reduce waste. They generally avoid selling a large number of items with quick expiration dates, and when food does indeed expire before it is bought, it has a predetermined destination like a food bank, rendering service or composting site. Rendering services collect inedible meat byproducts and repurpose them into ingredients for biofuel and other household products.

These stores are also conscious of where they order their products and aim to source locally if possible. Shopping locally and utilizing reusable packaging are two core parts of the process for a zero-waste store or any retailer that is aiming to get closer toward that coveted mark of producing no waste.



Pay for your items via smart shopping cart/ pay at counter

2 ZERO WASTE COOKING CLASS


RELEVANCE TO BRAND AND ISSUE



A channel for Bila-Bila Mart to raise awareness on food waste created by food production and preparation on household-commercial level. Utilizing fruits and vege to make jams and jellies before they turn bad.

WHY?



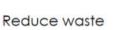



Aids environmental health



Improve people's nutrient intake

FINDINGS

Zero Waste Cooking: A Simple Guide to Eliminating Food Waste

2. Utilizing Vegetable Scraps

Cooking with scraps is one of the easiest ways to start zero waste cooking.

So many people throw away vegetable scraps that could be used in various recipes. If you're trying to *reduce waste* and make more sustainable choices, then you know how important it is to use any part of the food you buy.

Cooking with a conscience: Time to reduce food waste

Zero-waste cooking, or leaving no waste behind while preparing a meal, is not just a fad—it is a way of life for many. We dive deep into the concept with a focus on sustainability

Zero-waste cooking is one way to approach and reduce food waste.

Reprocessing meals into innovative and appetising options can put a stop to the monumental problem of food waste. It can also be a solution to climate

homemade recipes. A sustainable way to healthy cooking is to save waste and make nutritional food which will also save the environment. "Scraps are unavoidable products derived during food preparation. These scraps, from peels to roots, seeds, stems, stalks, etc, are often thrown. They are full of nutrients. Like a broccoli stem can be used to make pesto or cheese soup. All scraps are loaded with nutrition which we ignore," says Kumar.

3 COMPOST & BIO-ENZYME WORKSHOP

RELEVANCE TO BRAND AND ISSUE



A workshop that educates customer about food waste, learn about simple and easy ways to upcycle their organic waste by making a composter/ bioenzyme.

WHY?



Convert food waste into useful products



Reducing landfill waste



Improve soil health and decrease carbon footprint

FINDINGS

Upcycling Food: How You Can Reduce Food Waste And Help The Environment

Posted on October 7, 2022 by Henry Ford Health Staff @ 1811

Fruit peels, fresh herb stems and cheese rinds are parts of food you may toss into the trash. But more and more people are using these foods in recipes or adding them to a compost pile in the name of environmental sustainability.

"These efforts are called upcycling food, and yes, they can have a big impact," says Chip Amoe, J.D., M.P.A., Director of System Sustainability at Henry Ford Health. "If each of us cut back on the food waste we send to the landfill, we'd reduce food waste, save money and cut greenhouse gas emissions that harm the environment."

Upcycling Food Can Help Reduce Food Waste—and Anyone Can Try It

Upcycling is on the rise for food manufacturers and home cooks alike as they seek to reuse food scraps and byproducts that might otherwise be tossed.

Bio-enzymes – Making Sustainable Cleaners From Food Waste

June 4, 2022

Bio-enzymes or eco-enzymes are the product of 60-90 day fermentation of organic waste. The organic waste could be fruit and vegetable peels or spoiled whole fruits and vegetables.

Bio-enzyme uses

Bio-enzymes are the safer alternative to harsh chemicals we use daily in our households. They are safe for animals and the environment. You can use them in following ways:

Cleaning

- 1. Surface cleaners for mopping, cleaning shelves, tables, etc.
- 2. Laundry detergent by adding soapnut.
- 3. Dishwasher
- 4. Bathing, hand washing and hair washing.

4 VEGGIE GARDEN

RELEVANCE TO BRAND AND ISSUE



A channel for Bila-Bila Mart to maximize sustainability and value creation by having a store-grown fresh local veggies.

WHY?



Reduce carbon footprint of transportation



Eliminate food waste from supply chain



Pesticide-free crops

LOCAL VEGGIES:



Tomatoes



Chilli



Cucumbers



Spinach (Bayam)



Lettuce



Lime



Sawi

LOCAL HERBS:



Curry leaves



Pandan



Lemongrass



Coriander



Rosemary

5 SMOOTHIE BAR & BAKERY

RELEVANCE TO BRAND AND ISSUE



Providing an opportunity for grocers to use item in baked goods, smoothies, fruit and vegetable trays before they go bad.

WHY?



Give surplus fruits and veggies a second chance to be enjoyed

By Ivory Anne



Reducing food waste




Making use of "ugly" fruits and veggies

FINDINGS

Smoothie start-up upcycles fruit and veg waste: 'Why not make a product that people don't throw out?'

A Danish start-up is dehydrating fruits and vegetables for smoothies to reduce food waste – 40-50% of which is made up of this surplus, 'aesthetically unappealing', or overripe produce.

40% OF MALAYSIA'S FRESH VEGGIES ARE WASTED FOR BEING... "TOO UGLY". HERE'S WHERE IT GOES.

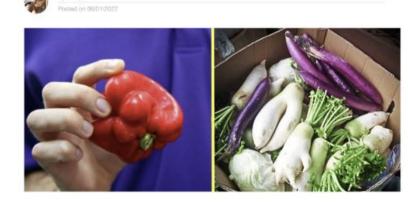

10. Blend It Up

Blending up a nutrient-packed smoothie can be a delicious way to reduce food waste

While the stems, ends and peels of produce may not be appetizing in their whole form, adding them to a smoothie is a way to reap their many benefits.


The stems of greens like kale and chard are packed with fiber and nutrients, making them a great addition to smoothies. The tops of beets, strawberries and carrots also make great addins.

Other items that would otherwise be discarded can also be thrown into a nutritious blend, including fruit and vegetable peels, wilted herbs, overripe bananas and chopped broccoli stalks.


PLANTING METHODS

METHOD 1: HYDROPONICS growing plants without soil, by using water based nutrient solution

TYPE: Deep Water Cultured (DWC)

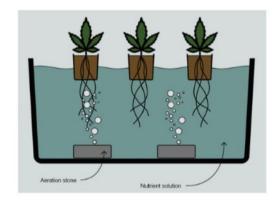

TYPE: Ebb & Flow (Flood & Drain)

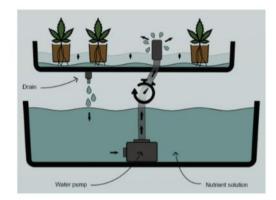

HOW IT WORKS

- 1. Plant roots are suspended in a nutrient solution
- Oxygen, water, nutrients
- 3. Air pump and air stone (to oxygenate the solution to prevent roots from drowning)

BENEFITS

1

- Low maintenance
- 2. Reduce plant growing time by half
- 3. Very little moving parts and assembly

HOW IT WORKS


- A water plant on timer periodically floods the plant with water from the nutrient solution
- 2. Water slowly drains back to the nutrient solution
- 3. Do not keep plant roots permanently suspended in nutrient solution.

BENEFITS

2

- 1. Easily transplant into any other system
- 2. Best fit for shorter plants like herbs

TYPE: Aeroponics

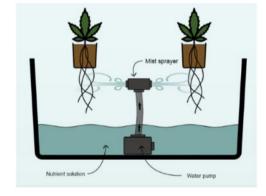

HOW IT WORKS

3

. A water pump draws water out of nutrient solution and sprays mist directly onto the roots of the pants

BENEFITS

- 1. Extra oxygen exposed results in faster growth
- 2. Ability to grow large quantities of food in small spaces
- 3. Indoor vertical farm
- 4. Use 95% less irrigation than plants grown in soil
- Can be employed in natural light

PLANTING METHODS

TYPES OF HYDROPONIC POTS AND PLANTERS

TERRAPLANTER: A HYDROPONIC POT THAT LET YOU GROW PLANTS INDOORS



WHAT ISIT MADE OUT OF?

Solid yet porous ceramic material

HOW IT WORKS

Act as a water bank that allows water slowly diffuse through it, allowing plant to grow on the exterior of the product's surface

The roots are exposed and cling onto the moisture structure with constant access to both air and water

The roots are exposed and cling onto the moisture structure with constant access to both air and water.



PLANTING METHODS

CONCLUSION:

1

VEGGIE GROWING TYPES



Loam Soil



Deep Water Cultured (DWC)



Ebb & Flow (Flood & Drain)

Cucumbers



Aeroponics



Pandan





Curry leaves



Lemongrass



Lime



Chilli



Coriander



Sawi

Sweet Basil



Spinach (Bayam)



Tomatoes

Rosemary



4

Lettuce



Rosemary



BaseHall

Food Hall / ShangHai, China

Concept, Materiality, Lighting

Net Area | 550 m

GF

Architecture | Linehouse

Base Hall is a contemporary, **high end food hall**, bringing together Hong Kong's top 7 artisanal food and bar operators in one location.

1F

Concept / Theme / Scheme

Early Cinematic Depictions
Of Jardine House in cinema during the early 1970s.

Retro-flavoured and soft-blue hues that drew on its 1970s cinema design constitute a retro yet modern atmosphere.



Ground Floor - The "market courtyard"
Bright, Open & Festive
Offering treats from seven artisanal Hong Kong food vendors.



First Floor - "Upper bar" Warmer & More intimate A drink bar.

Retail Experience

Split across two levels, the space has **two distinct** identities – the "market courtyard" which is bright, open and festive, and the "upper bar" which is conceived as a warmer and more intimate space.

Aims to serve relatively refined food and drink in an atmosphere that invites people to linger.

PRECEDENT Materiality / Lighting


Wall & Lighting half-moon shape canopy fitted with spherical lights



white-tile niches

Wall Clad oakwood battens



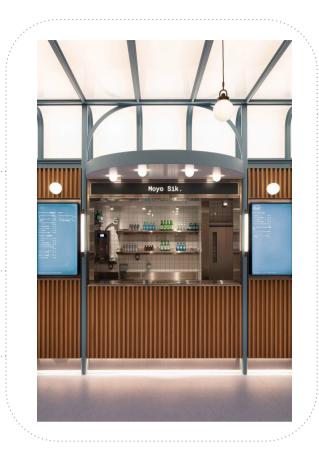

Ceiling backlighting + diffused glass

(creates illusion of exterior natural light)

as well as create atmospheric rainbow hues that respond to music and people dancing



powdered-blue arch frame and metal canopy

(references vaulted market hall structures)






Ceiling
lighting system
Custom lighting allows for more
dynamic lighting effects during
events and at night.

Materiality / Furniture

Dynamism

Mobile cashier carts and moveable DJ booth allow the space to be easily re-configured to host live music events or performances. Custom furniture is flexible and stackable.

Materiality Stainless Steel Bronze

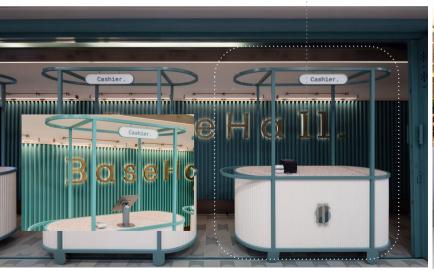



Furniture Modular tables and seatings

Repurposed materials
Discarded metal rods that were repainted a dusty pink and marble left over from another project, which was used for bar counters.





The copper rods that previously hung from the ceiling of the previous tenant have been repurposed as decorations for the bathroom walls and cubicles.

Vanity & Flooring
Green Terrazzo

Atmosphere

"See and be seen" vibe
Where diners hanging out at the bar can keep tabs
on tables on the level below.







62 Beiting Lane Store Retail / Nan Jing, China

Relationship to city context, Approach

Net Area | 600 m² Architecture | MOU Architecture Studio

Located in the intersection between Yangtze River Road and Beiting Lane. These two roads have witnessed the rise and fall of prosperity in Nanjing's history. Thus, inevitably shaped the different texture of the city at different times.

Reflection on the relationship between shop and street

Neighbouring Building Long queues of shop crowd the pavement, affects traffic Main Entrance & Large windows Narrow Street on road & no shelter for rain One way street Facing Street

Large Eaves
Inspired by the eaves of the traditional sloping roof of the building, the two levels of space were set back inwards to form a gable open to the outside.



Visual Penetration

Staircase has been shifted to the far left of the entrance in order to create an urban living room that can be penetrated by traveler from the street.

Internal space, External gable

Integrated with the external street through a system of folding glass doors, releasing a sense of friendliness to the city and street.

No Visual Barriers

Display arrangement use mainly wall space, and leave the flexible use mechanism of the central core to the shop operators.





Relationship to the city street and people

Routine

Taking the most impressive things about the city streets as inspiration, introducing a 'kiosk' where pedestrians can notice the process of making coffee.

Equality

Height of flooring is same level inside and outside, thus the line of sight between shop staff and customers is the same level.





View In From store



Lowered facade and frontage Maintain equal line of dialogue with opposite building

Brick-Built Curb and Raised sections Customers sit & talk (serves as booths and benches)

PRECEDENT Square and curved atrium

High Parapet Wall & Geometric forms Serve to divide the space and act as a visual cover. To add more complexity and interest, combinations of geometric forms were introduced.

Sense of continuity

The site is held up by beams and columns, to break out of this initial homogeneity and create an impression of a shop that is exploratory and takes time to wander.





Engaging with scenery and the body


Follow your feelings and preference Customers explore a selective and disorienting path based on their feelings.

Punctured walls and openings

Unexpected and penetrating openings where air and sunlight can flow naturally, views peeking through drives the body to wander the space.





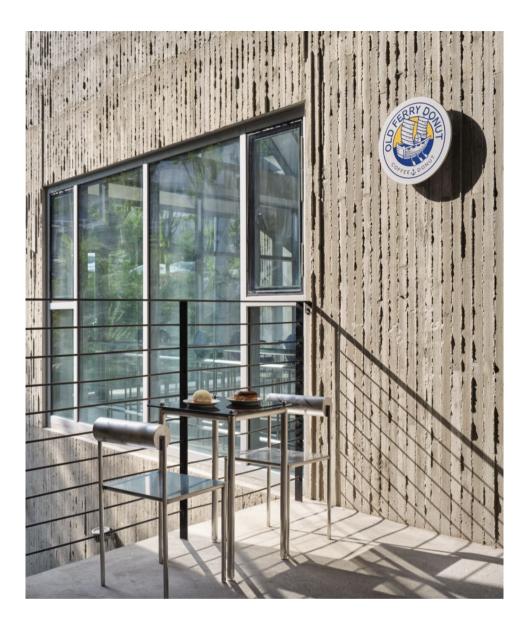


Concept / Theme

Korean elements and aesthetic

To demonstrate to foreign tourist that Korea also has delicious donuts, thus the space embodies distinctive Korea aesthetics.

Natural and oriental ambience


Through the selection of materials: lauan plywood, walnut, brass, and stone.

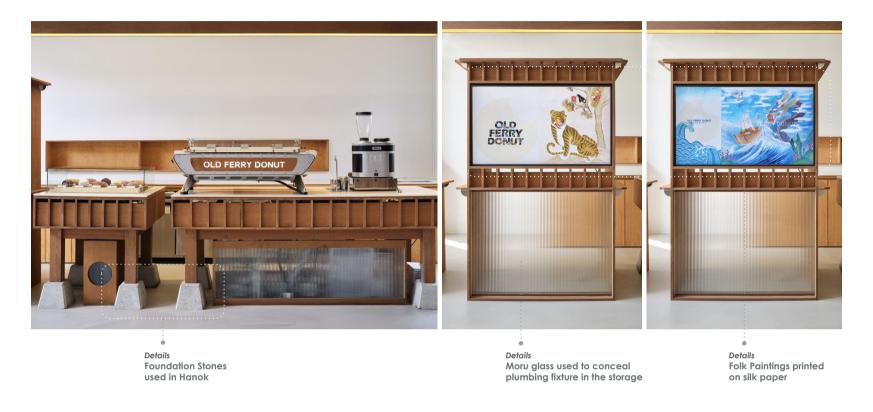


Concept / Furniture

Simple yet dynamic

Reinforce identity The cushions/backrest are applied in the brand's signature blue colour.

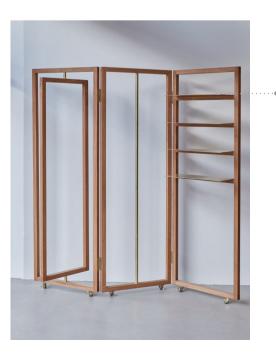

Details Korean folding screen partition Accommodate merchandise & creates separation within the space

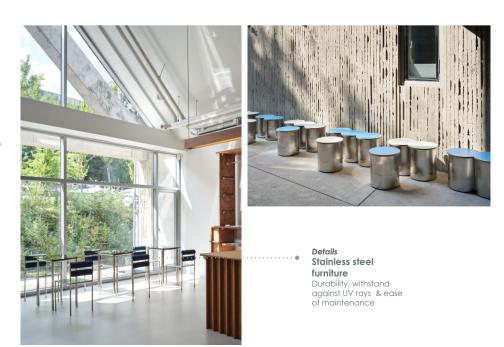

Old Ferry Cafe Cafe / Yongsan-gu, Seoul

Concept, Furniture

Net Area | 86 m²

Architecture | Studio Gimgeosil

A donut cafe that explores **Korean elements and aesthetic** inside the store.

SPACE LISTING



Customer Area

- Low Waste Grocery Store Zero Waste Cooking Class
- Zero Waste Cooking Class
 Dining Area
 Cooking Area
 Compost & Bio Enzyme Workshop
 Veggie Garden
 Smoothie Bar & Bakery
 Restroom

Staff Area

- Cashier Storage Area Stock Room Security Room Kitchen Unloading Area

PUBLIC 75%




Low Waste Grocery Store Merchandise + Kiosk Rental Smoothie Bar & Bakery Veggie Garden Restroom **ZONING**


Zero Waste Cooking Class Compost & Enzyme Workshop

7 Stock Room Security Room Store Room PRIVATE 5%


SPACE CONNECTIVITY

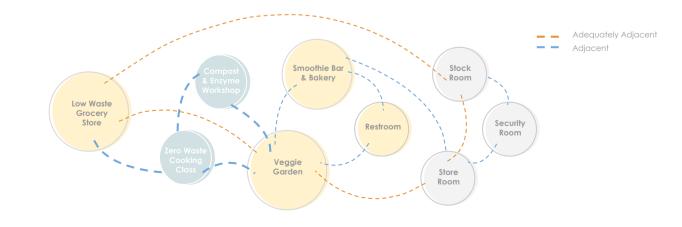

SPACE PLANNING

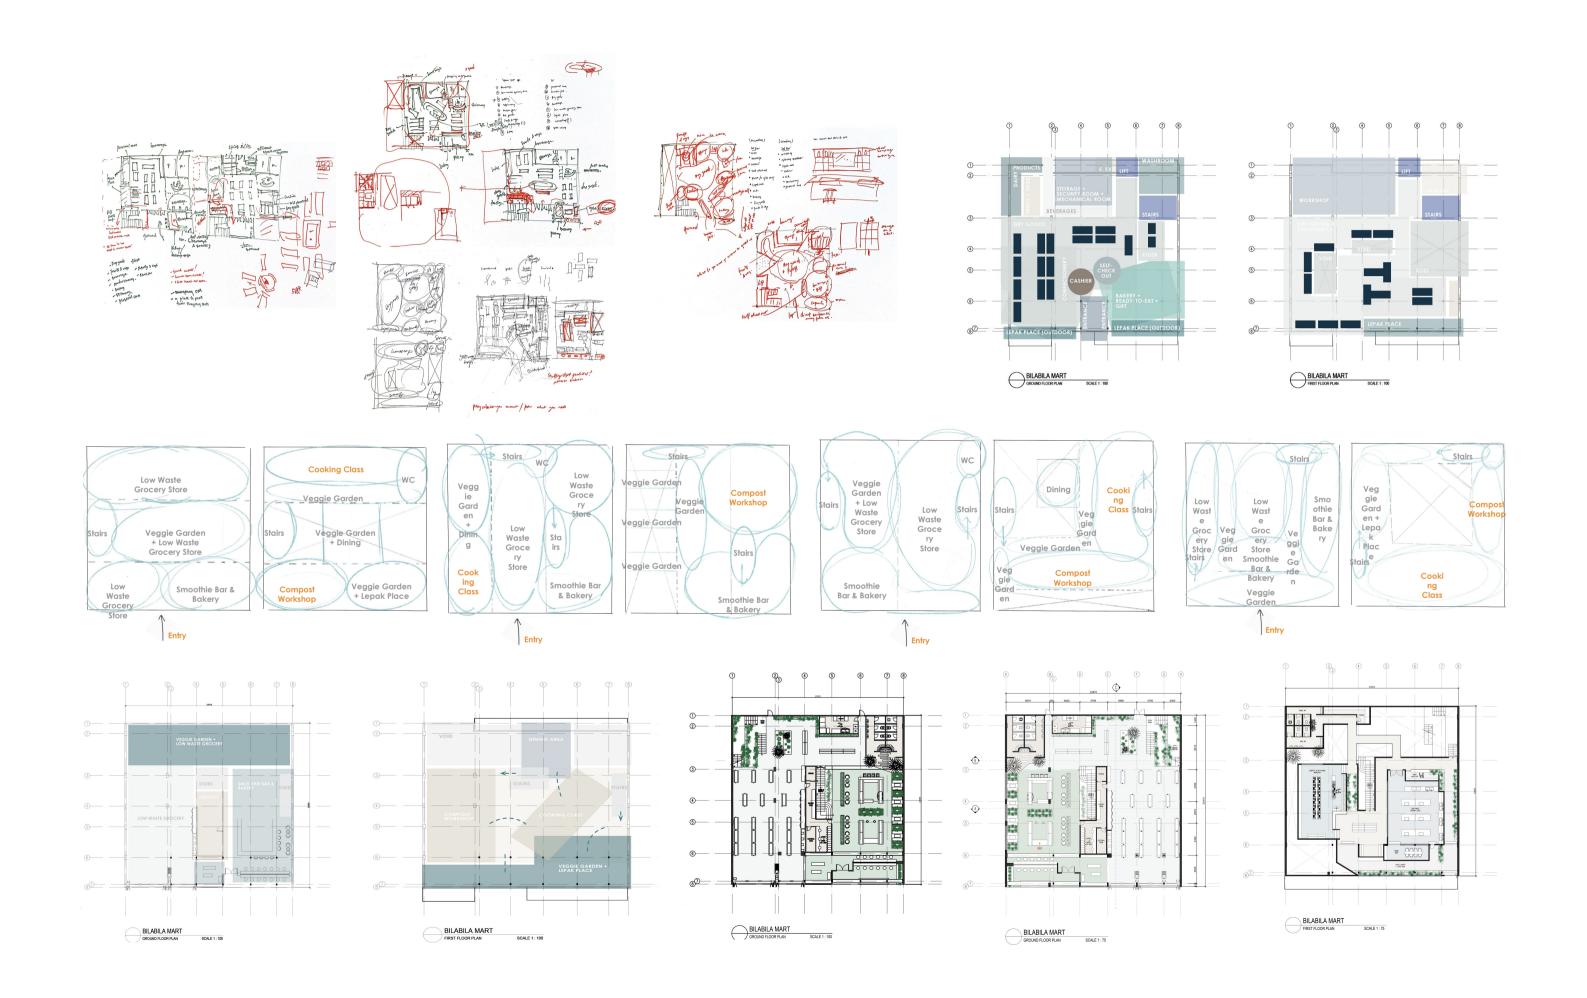


LOW WASTE GROCERY STORE

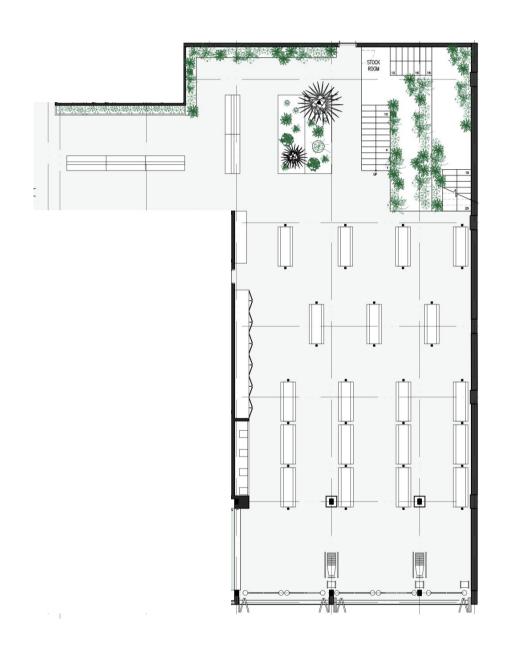

CEILING // Wooden loom structures interlaced with metal wire LIGHTING // 15W Black Helen 40 track light Green metal colums with customised green glass lamp WALL // Lattice Screen Festoon Aqua Blue Paint FURNITURE // OLEA Austin Desktop Bill Payment with Barcode / QR scanner White Gladstone Oak Stainless Steel FLOORING // 40~95cm (w) x 25~115cm (l) Abbey's Fossil Raw Stone


SMOOTHIE BAR & BAKERY

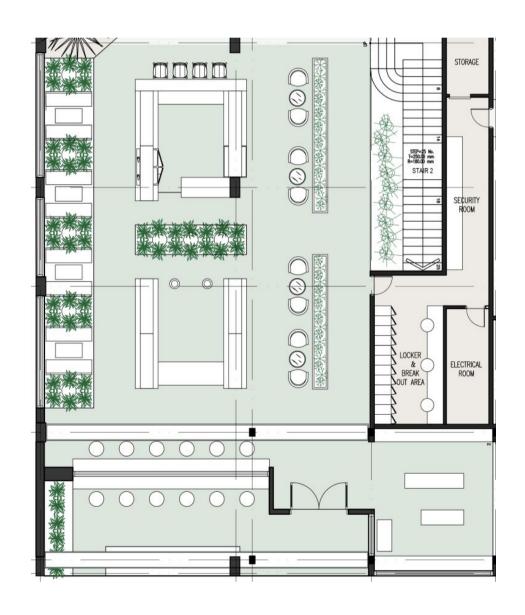





VEGGIE GARDEN



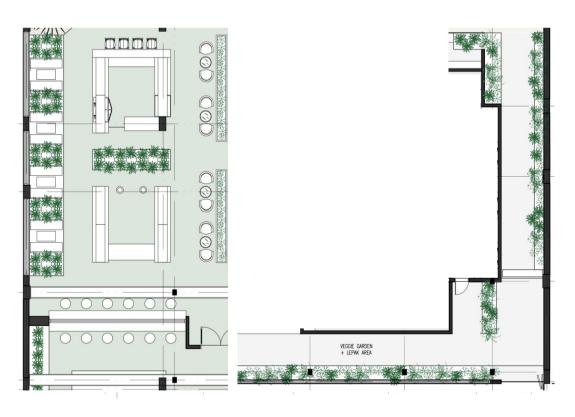

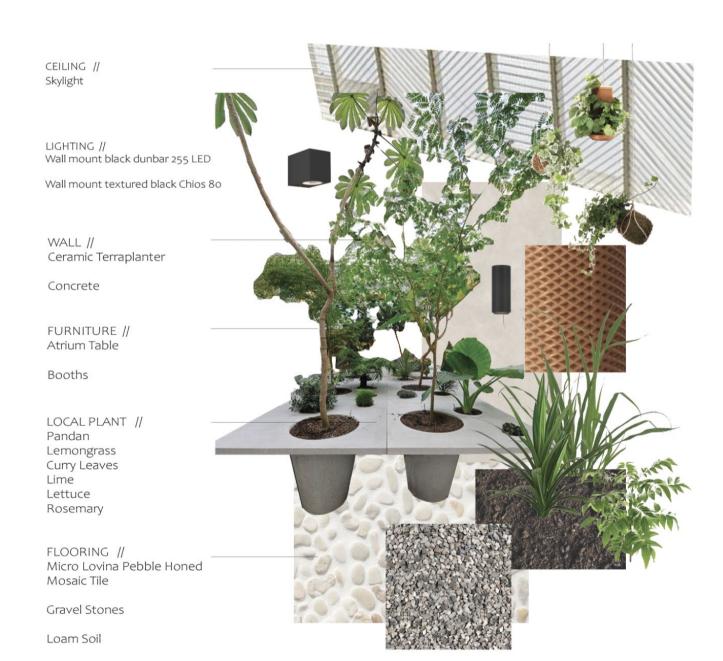

COMPOST & BIO ENZYME WORKSHOP

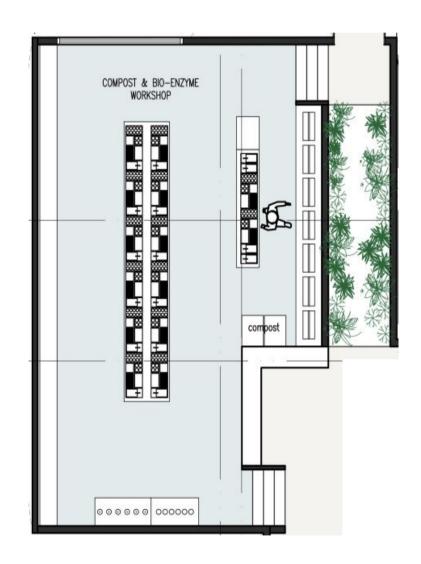

CEILING //
Polycarbonate Skylight

LIGHTING // Daylight light panel

Kos II Matt White

Bayville Spike Spotlight

WALL // 2" Grid Mediterranean blue matte Ceramic mosaic

Louvered window screens

FURNITURE // Maeko MunchBOT MBo5

Customised compost and bio-enzyme Workstation Bar

Customised Metal Showcase

Festoon Aqua stained Oak covering

Stainless Steel

LOCAL PLANT // Pandan Lemongrass Curry Leaves


FLOORING //
60x120cm Stone Look Procelain Tile -Pure

Rushmore Rock Gray 24x24 Matte Porcelain

Loam Soil




COMPOST & BIO ENZYME WORKSHOP

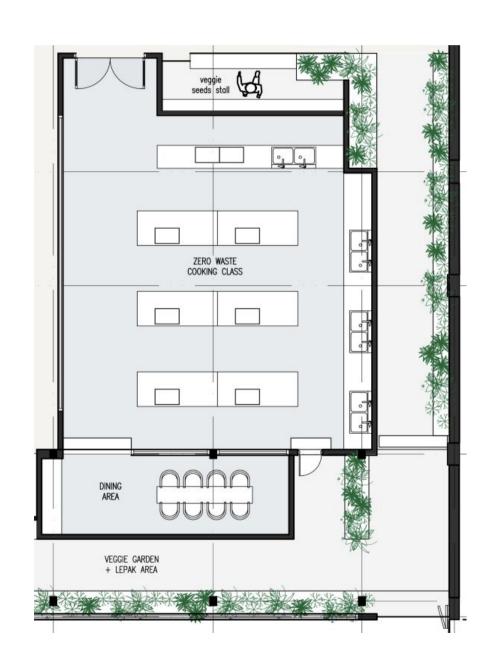



COMPOST & BIO ENZYME WORKSHOP

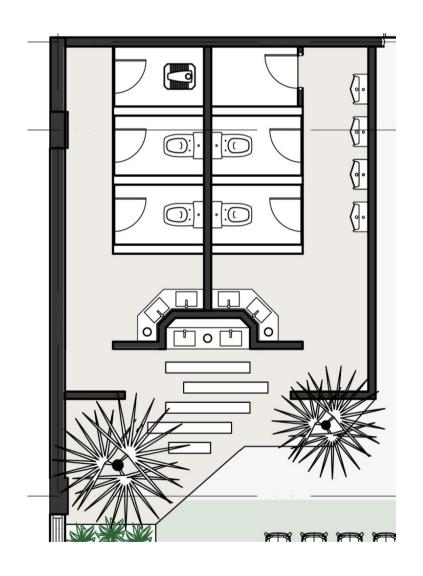




LOW WASTE GROCERY STORE



FLOOR PLAN

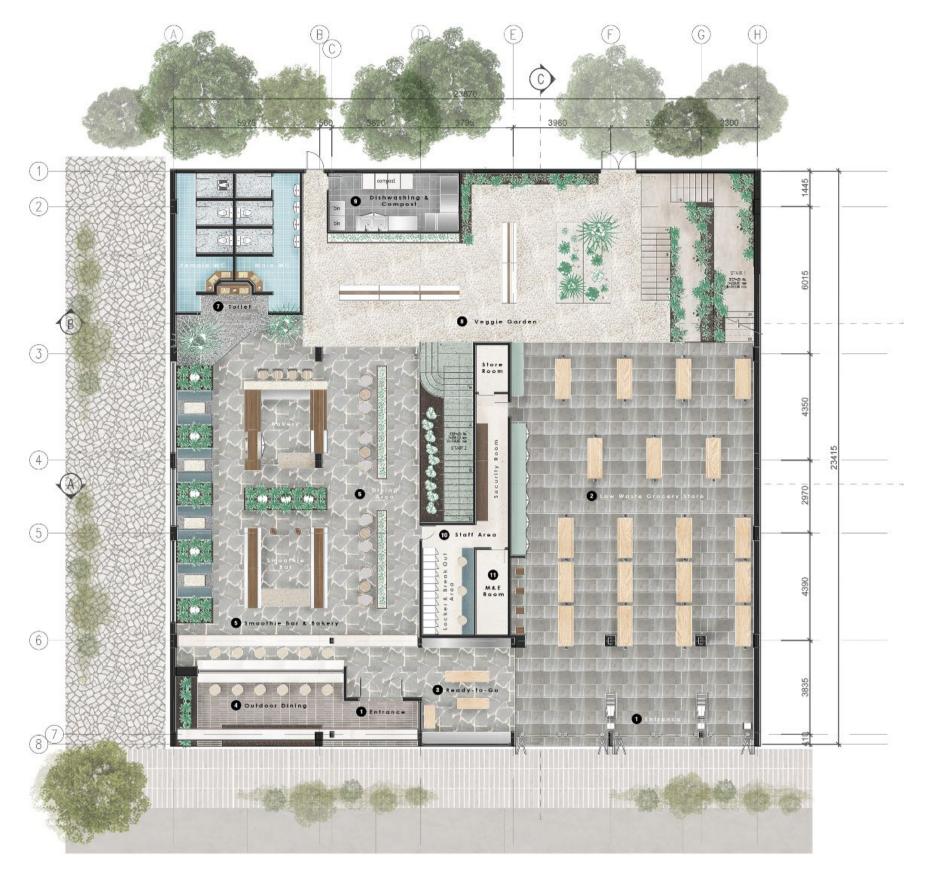

BILABILA MART GROUND FLOOR PLAN

R PLAN SCALE 1:150

LEGEND

- 1. ENTRANCE
- 2. LOW WASTE GROCERY STORE
- 3. READY-TO-GO
- 4. OUTDOOR DINING
- 5. SMOOTHIE BAR & BAKERY
- 6. DINING AREA
- 7. TOILET
- 8. VEGGIE GARDEN
- 9. DISHWASHING & COMPOST ROOM
- 10. STAFF AREA


LOCKER & BREAK OUT AREA

SECURITY ROOM

STORE ROOM


11. M&E ROOM

FLOOR PLAN

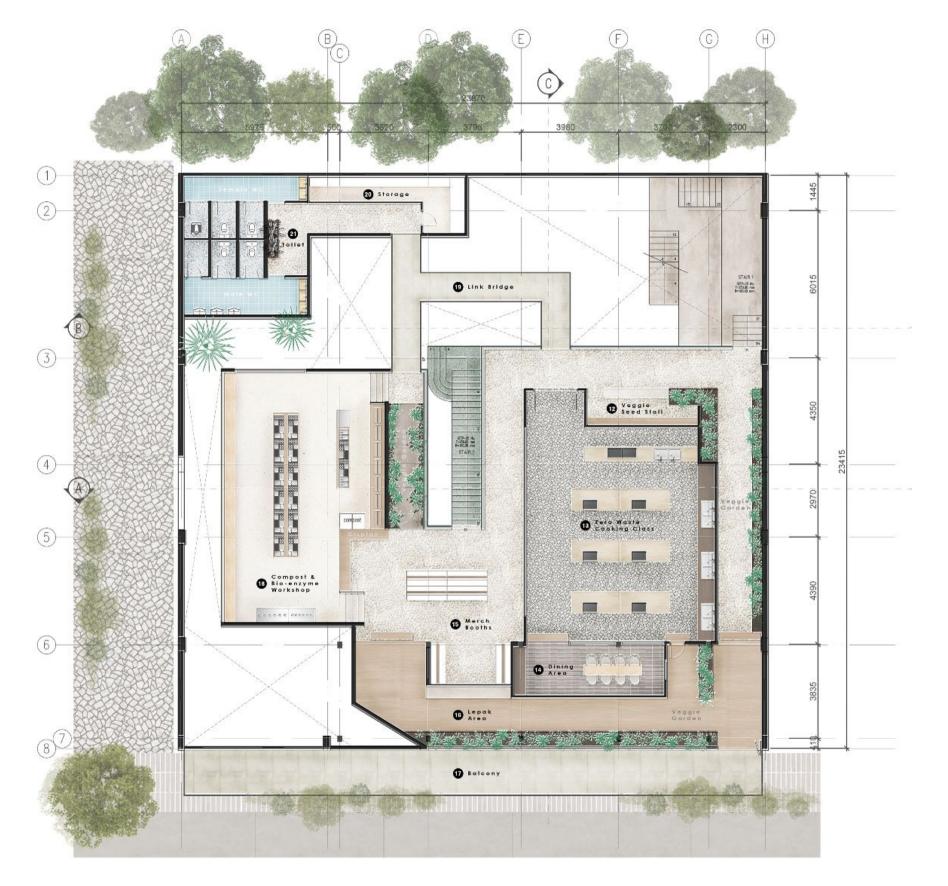


LEGEND


- 12. VEGGIE SEED STALL
- 13. ZERO WASTE COOKING CLASS
- 14. DINING AREA
- 15. MERCH BOOTHS
- 16. LEPAK AREA
- 17. BALCONY
- 18. COMPOST & BIO-ENZYME WORKSHOP
- 19. LINK BRIDGE
- 20. STORAGE
- 21. TOILET

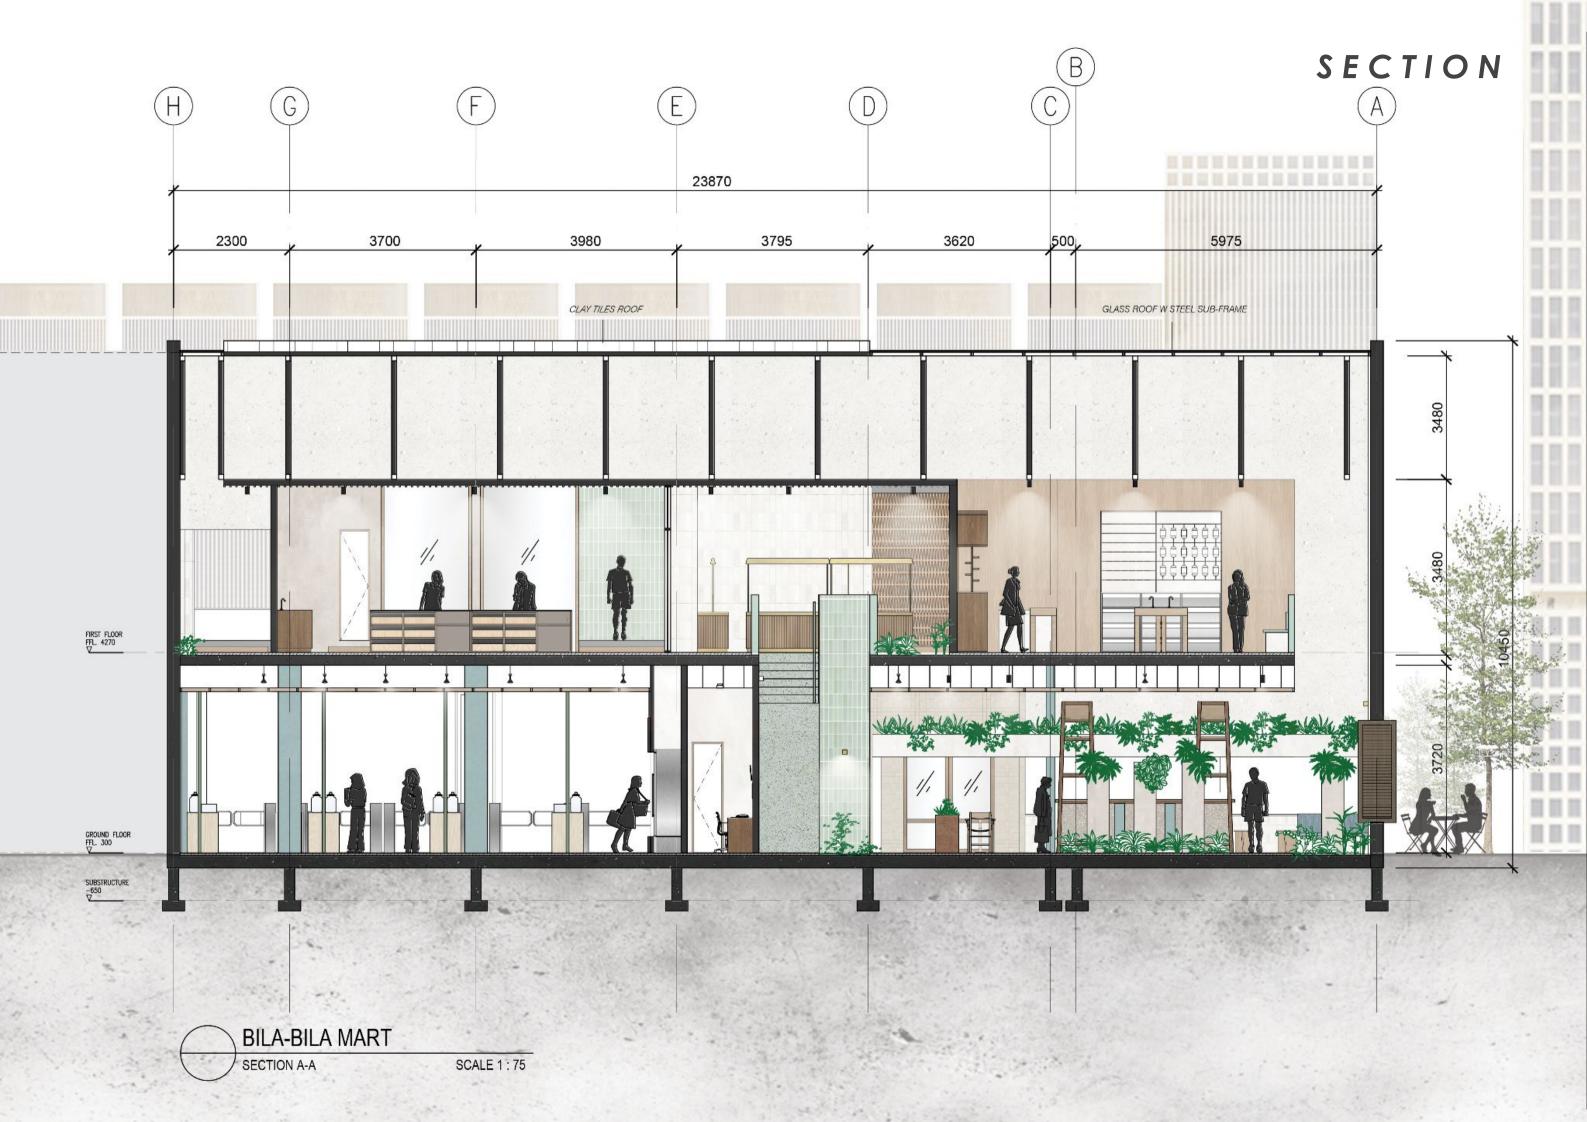



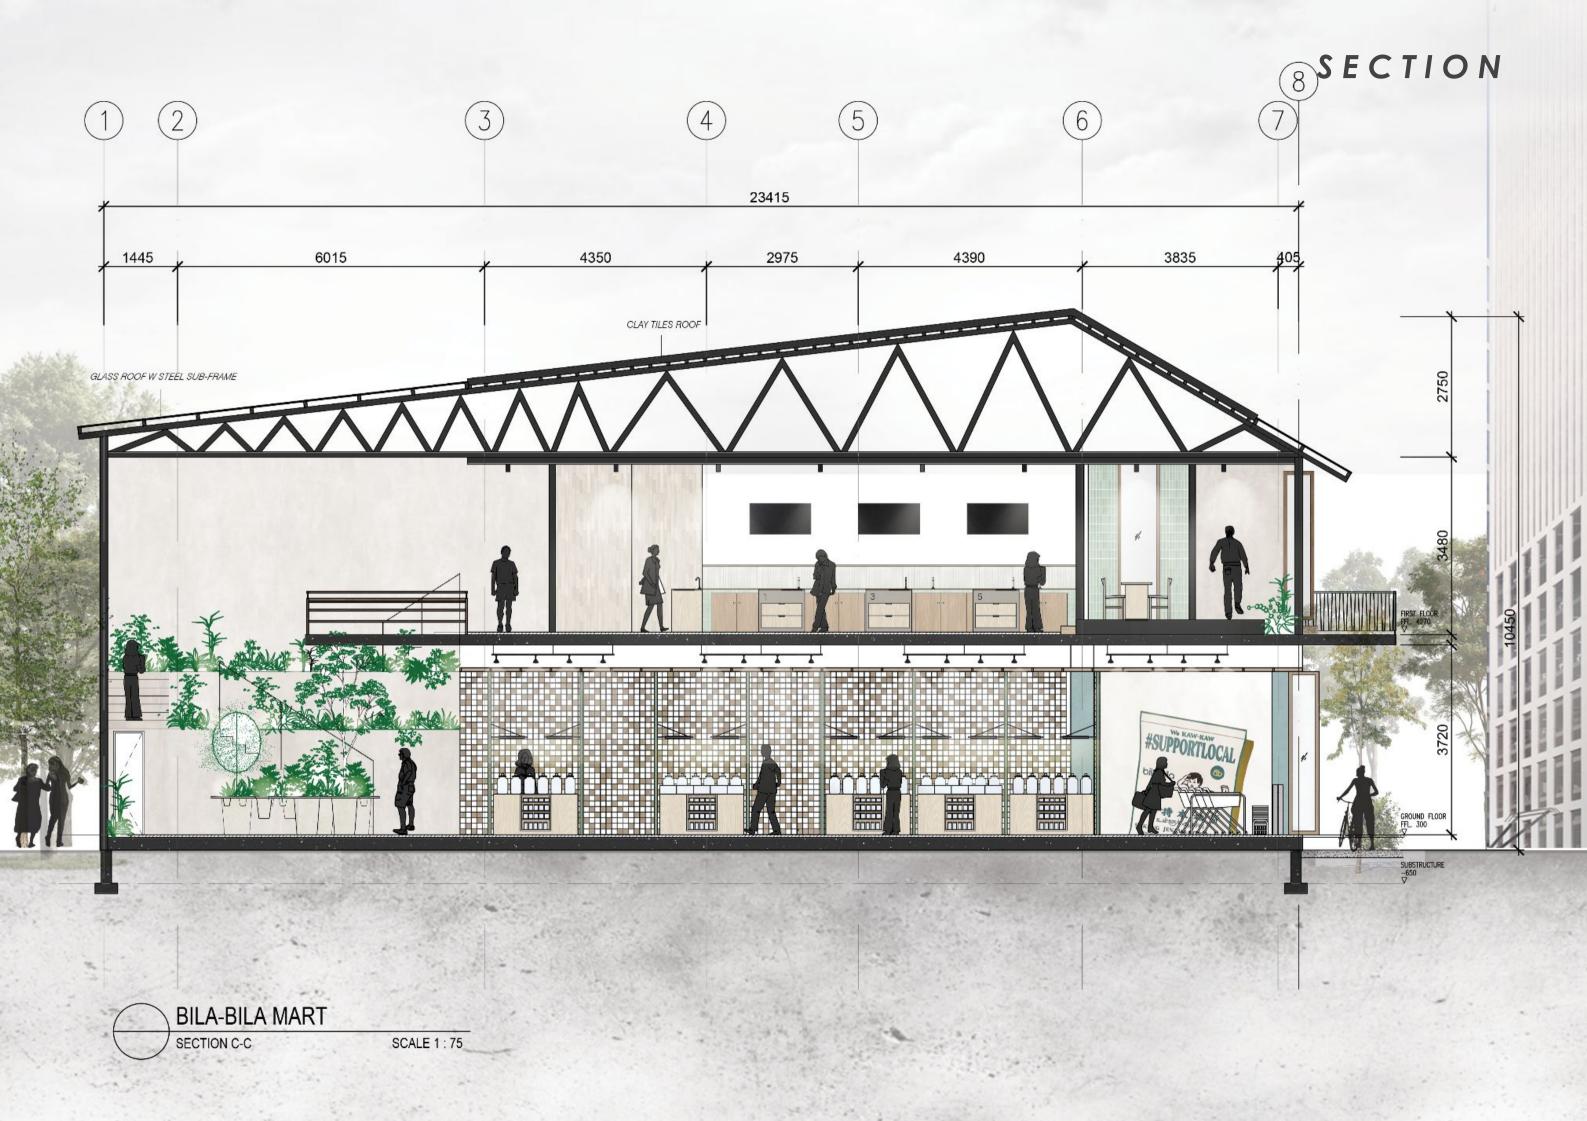


RCP

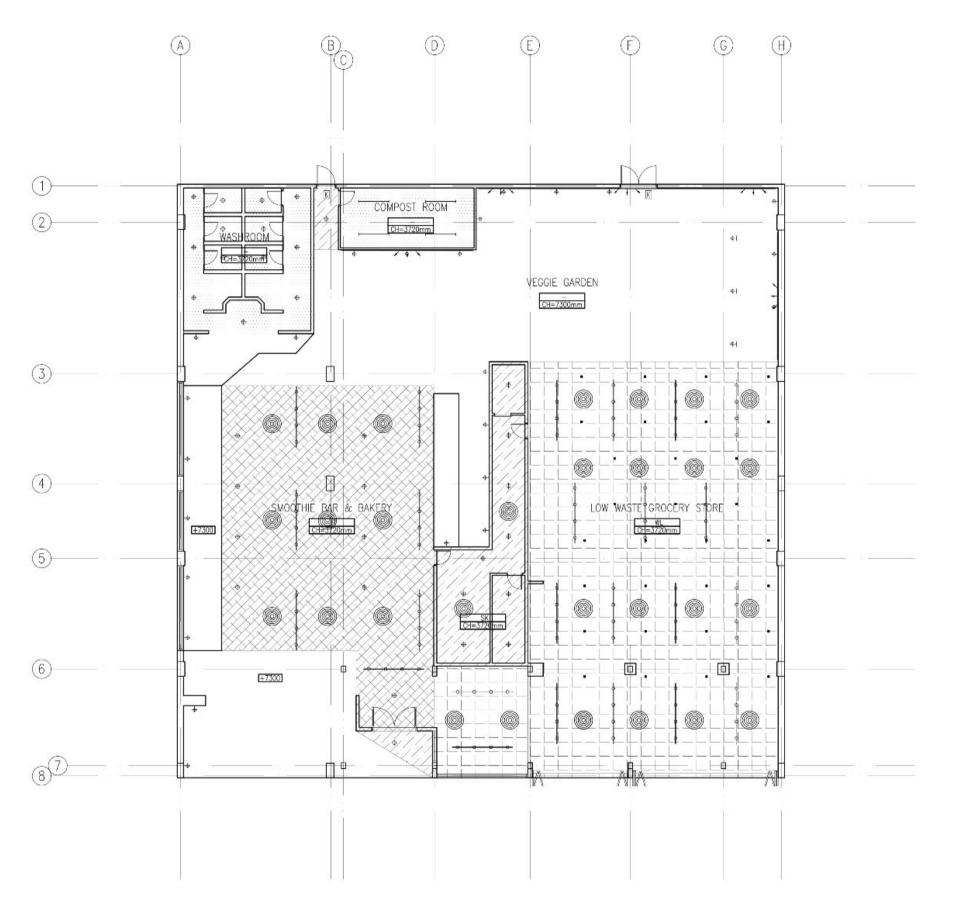

BILABILA MART	
REFLECTED CEILING PLAN - GF	SCALE 1:75

SYMBOL	CEILING FINISHES
WG	WETSTOP GYPSUM BOARD (600 x 1200)
SK	SKIM COATED & PAINTED
TS	HW TIMBER STRIP (125 x 12)
ντγ	TIMBER STRUCTURE
WE	WOODEN LOOM STRUCTURE
SYMBOL	DESCIPTION
+	DOWN LIGHT
Ф	PENDANT LIGHT
• • •	TRACK LIGHT
1-0	WALL LIGHT POINT
	FLUORESCENT LIGHT
7	SUPPLY AIR GRILLE
0	CEILING DIFFUSER ROUND
K	KELUAR SIGN

RCP

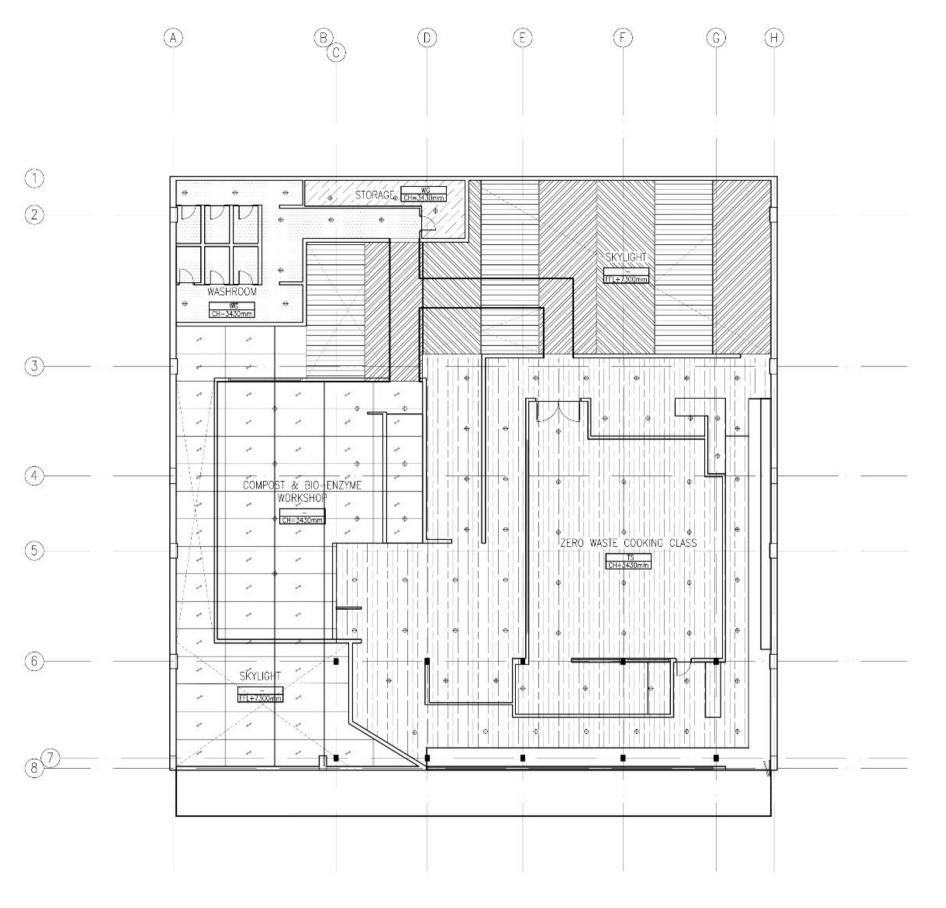


BILABILA MART

REFLECTED CEILING PLAN - 1F SCALE 1 : 75

SYMBOL	CEILING FINISHES
WG	WETSTOP GYPSUM BOARD (600 x 1200)
SK	SKIM COATED & PAINTED
TS	HW TIMBER STRIP (125 x 12)
ντ	TIMBER STRUCTURE
WE	WOODEN LOOM STRUCTURE

SYMBOL	DESCIPTION
ф	DOWN LIGHT
Ф	PENDANT LIGHT
-0-0-	TRACK LIGHT
Ι÷	WALL LIGHT POINT
-	FLUORESCENT LIGHT
7	SUPPLY AIR GRILLE
	CEILING DIFFUSER ROUND
K	KELUAR SIGN

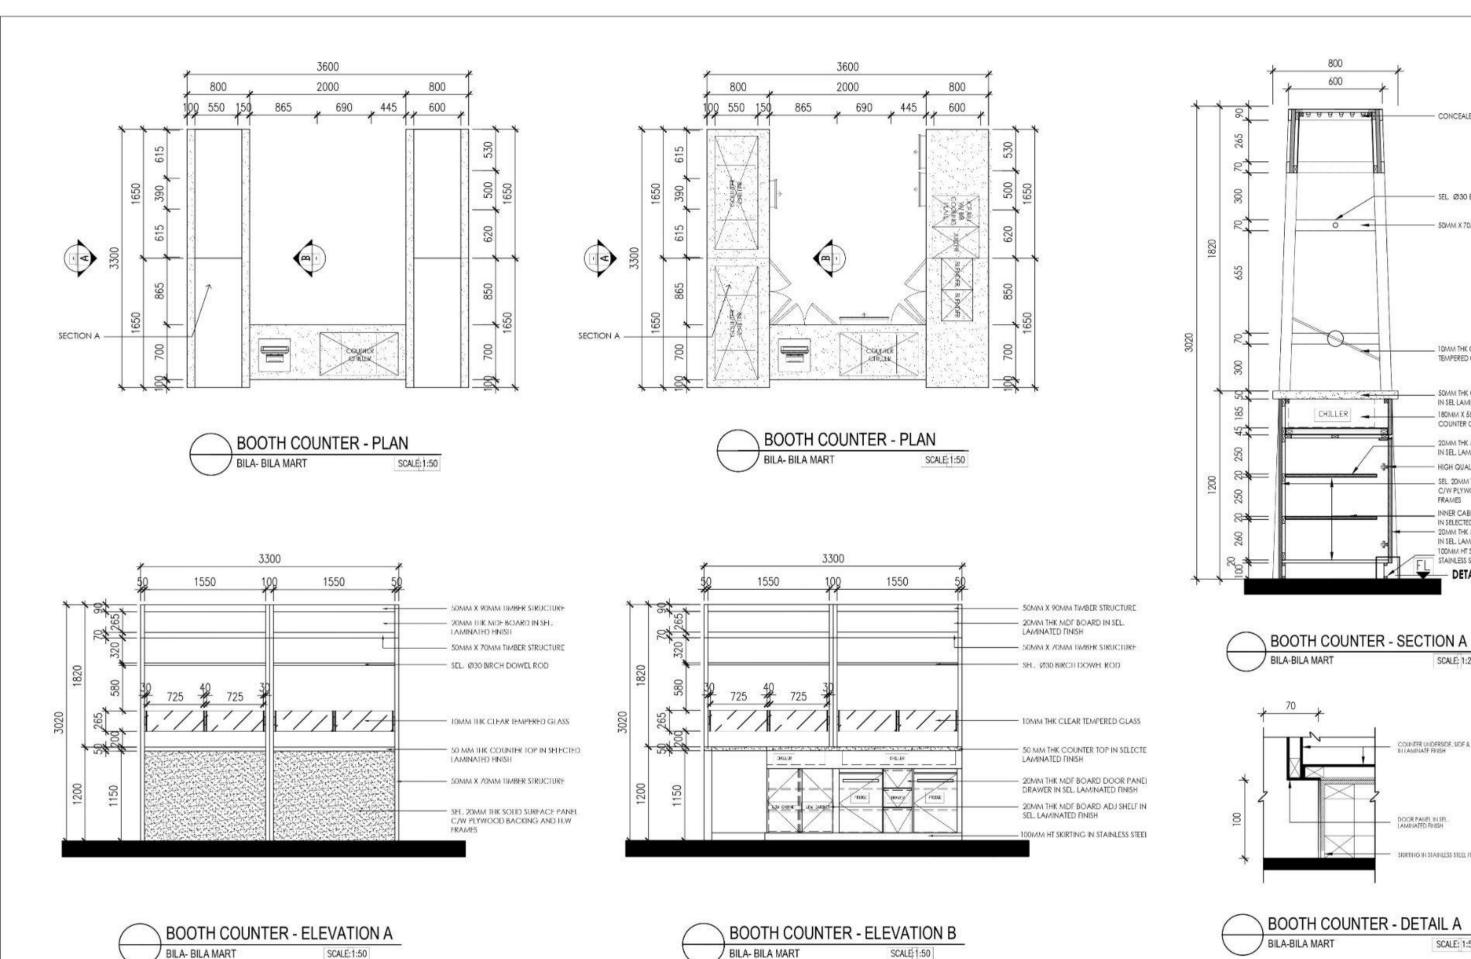

DESCRIPTION REV. DATE

DESCRIPTION

ACCEPTED BY:

INTERIOR DESIGNER:

DETAIL DRAWING TITLE : BILA-BILA-MART BOOTH-COUNTER CHECKED BY SHWEN SCALE 13-JULY-23 DRAWING NO: REV

800

600

CONCEALED TO TASK LIGHT

SEL Ø30 BIRCH DOWEL ROD

SOMM X 70MM TIMBER STRUCTURE

10MM THK CLEAR TEMPERED GLASS

. 50MM THK COUNTER TOP IN SEL LAMINATED FINISH

180MM X 550MM X 1450MM COUNTER CHILLER

IN SEL, LAMINATED FINISH

FRAMES

20MM THK MDF BOARD ADJ SHELF

HIGH QUALITY SOFT CLOSE HINGES

SEL 20MM THK SOLID SURFACE PANEL C/W PLYWOOD BACKING AND H.W

INNER CABINET AND SHELVING IN SELECTED LAMINATED FINISH 20MM THK MDF BOARD DOOR PANEL

IN SEL, LAMINATED FINISH 100MM HT SKIRTING IN


STAINLESS STEEL FINISH DETAIL A

SCALE: 1:25


COUNTER UNDERSIDE, SIDE & SHELVING IN LAWINATE FRISH

SKIRTING IN STAINLESS STEEL FINISH

SCALE: 1:5

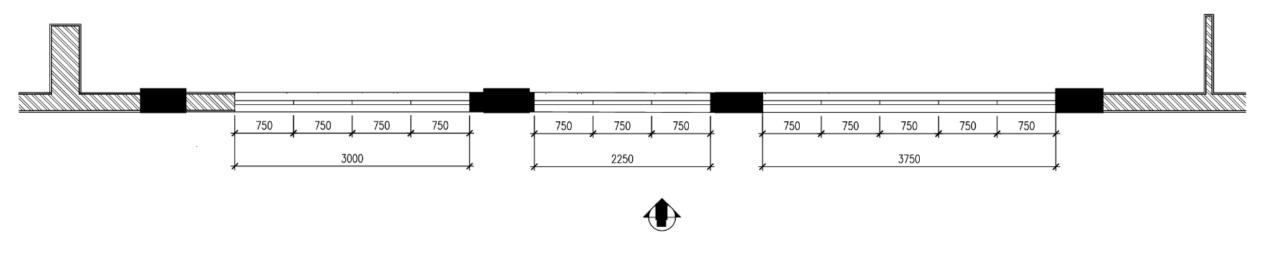





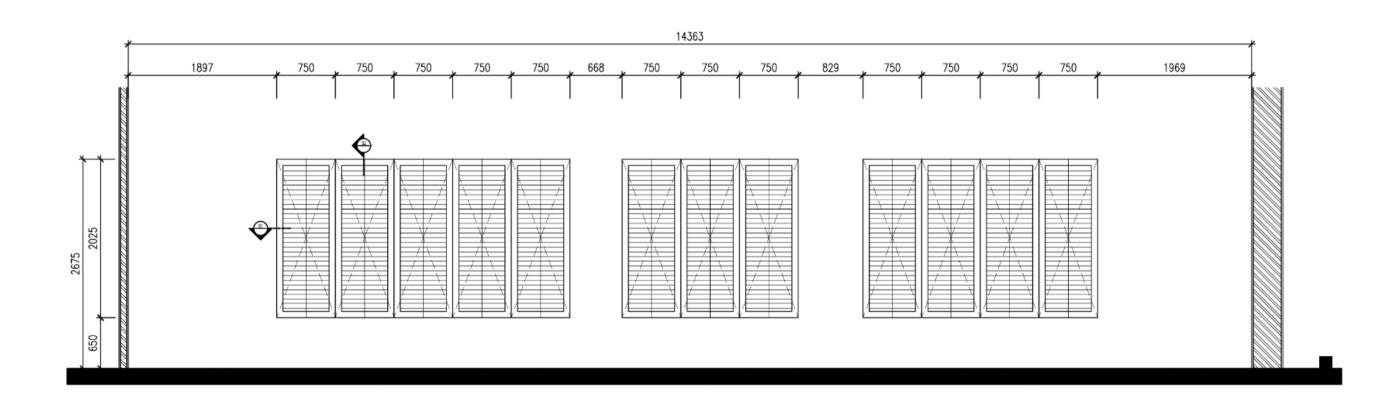





							DETAIL DRAWING	
REV.	DATE	DESCRIPTION	DESCRIPTION	ACCEPTED BY:	INTERIOR DESIGNER:	TITLE :	_	
				1		BILA-BILA-MART		
				1		LOUVERED-PIVOT-PANEL-WINDOW	1	
			-			DRAWN BY SHWEN	CHECKED BY	
						DATE 16-JULY-23	SCALE -	
				1		DRAWING NO :		REV
				1				REV
	I	1	1	1	I			I

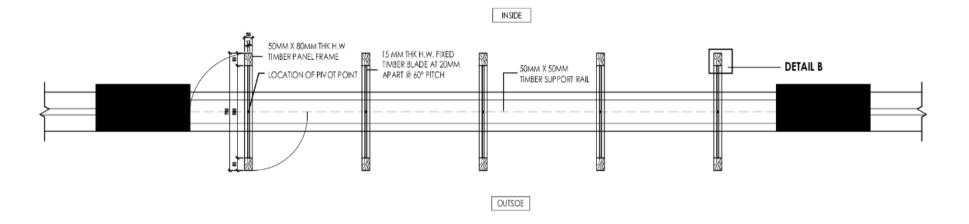

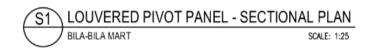


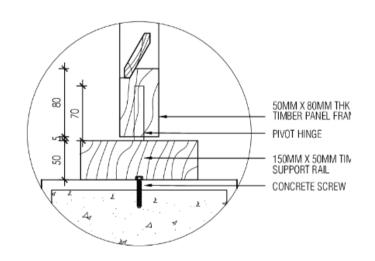

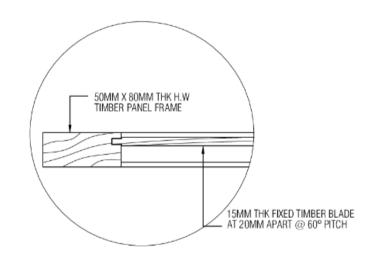







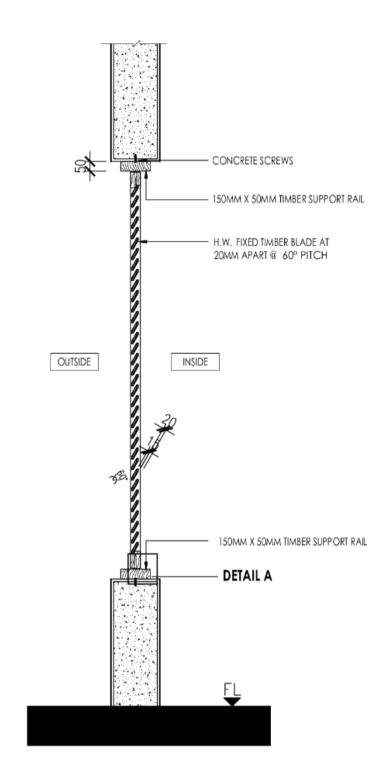





							DETAIL DRAW	ING
REV.	DATE	DESCRIPTION	DESCRIPTION	ACCEPTED BY:	INTERIOR DESIGNER:	TITLE :		
						BILA-BILA-MART		
						LOUVERED-PIVOT-PANEL-WIN	IDOW	
						DRAWN BY	CHECKED BY	
						SHWEN	<u> </u>	
						DATE 16-JULY-23	SCALE -	
						DRAWING NO :		REV
								REV
			1					1

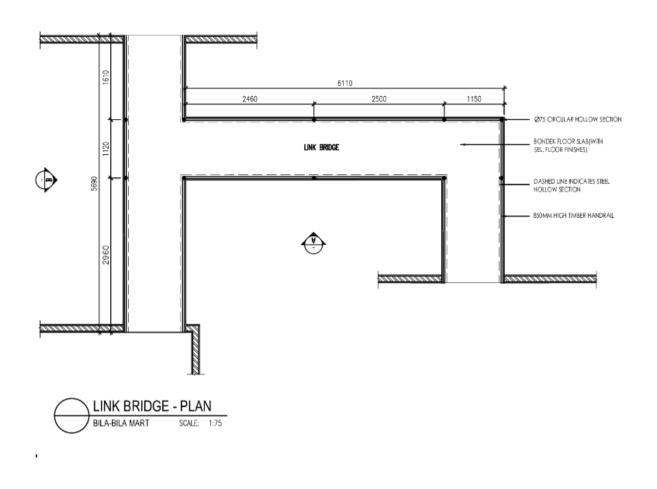


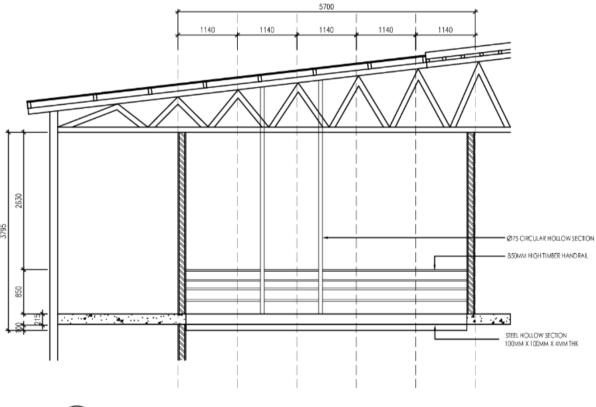

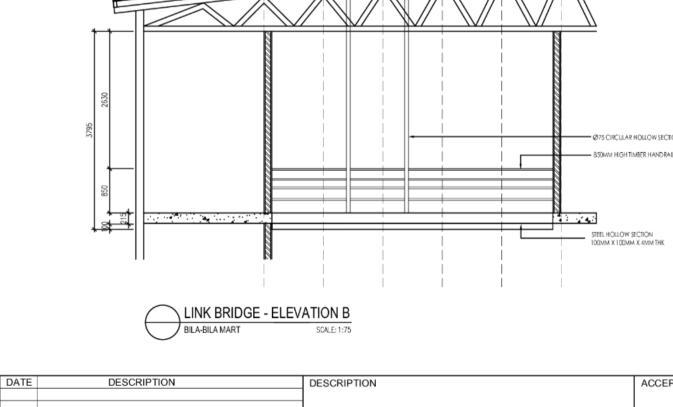

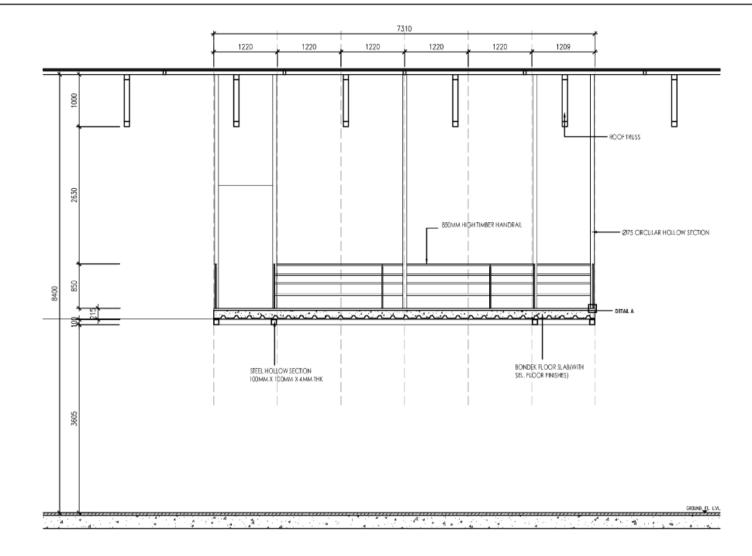



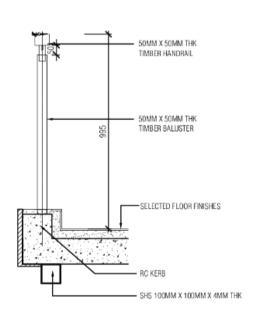



DETAIL DRAWING

								50
REV.	DATE	DESCRIPTION	DESCRIPTION	ACCEPTED BY:		TITLE:		
						BILA-BILA-MART		
						LINK-BRIDGE		
						DRAWN BY SHWEN	CHECKED BY	
							•	
						DATE 16-JULY-23	SCALE -	
						DRAWING NO :	<u> </u>	REV
								REV

SUSTAINABLE DESIGN

ENVIRONMENTAL









1 VEGGIE GARDEN - HYDROPONIC / AEROPONICS / INDOOR PLANTS

Creates a comfortable microclimate throughout the building

Vegetation filters direct sunlight / purifies the air

Various local veggies, herbs and fruit trees (contribute to the biodiversity of the region)

Improve indoor environmental quality

TECHNOLOGY







2 SOLAR WINDOWS & SKYLIGHT (PHOTOVOLTAIC GLASS)

HEALTH / WELL BEING







3 LARGE SPACE OPEN - AIR

Promotes natural ventilation and allows cross-ventilation (natural coolina)

Natural lighting (daylight floods the space through large open space and high level skylights

Create a healthy and vibrant space

Highly cost-effective means of reducing the energy for electrical lighting

MATERIALITY







4 NATURAL MATERIALS: CLAY PAVERS, STONE, WOOD

Can be recycled (no harmful high Durability

Weather Resistance

Impervious to fungi and bacteria that can cause decay

SUSTAINABLE DESIGN

OPERATIONS











6 CIRCULARITY / SUSTAINABLE OPERATION

Market sustainability activities, green operations

Eliminate / Reduce food waste

Reduce plastic waste and packaging circularity Reduce carbon footprints by having own veggie production



ENTRANCE / LOW WASTE GROCERY STORE



LOW WASTE GROCERY STORE





LOW WASTE GROCERY STORE



READY TO GO





VEGGIE GARDEN





SMOOTHIE BAR & BAKERY



SMOOTHIE BAR & BAKERY





MARKETPLACE & VEGGIE SEED STALL



ZERO WASTE COOKING CLASS & COMPOST / BIO ENZYME WORKSHOP



THE MARKETPLACE TIES

Ties: a thing that unites or links people, connect

The Marketplace Ties is a reinterpretation of a traditional marketplace while tying the brand culture with local culture, traditional with modern, the past with the future. The valued moments in a marketplace are manifested into the space through veritable maze of alleys and ethos of open-armed hospitality. Capturing the pulse and texture of traditional marketplace, tying together people and products into one community.





SWOT

STRENGTHS

High concentration of businesses - High activity and human node Rich in culture & historical interest WEAKNESS / ISSUE

Site is mostly flocked with upscales eateries Food waste from eateries Social & Economic disparity

OPPORTUNITY Encourage visits of visitors of different social and eco

Sustainable practices

THREATS Challenges in rich city image

ISSUE / SOURCE OF FOOD WASTE IN CHOW KIT AREA TARGET AUDIENCE




CLIENT

Bila Bila Mart

" KEDAI RUNCIT REIMAGINED '

A Malaysian covenience grocer, inspired by Malaysian's culture. heritage and food.

Housing Malaysian-produced groceries, Bila-Bila Mart is a proud supporter of homegrown Malaysian brands.

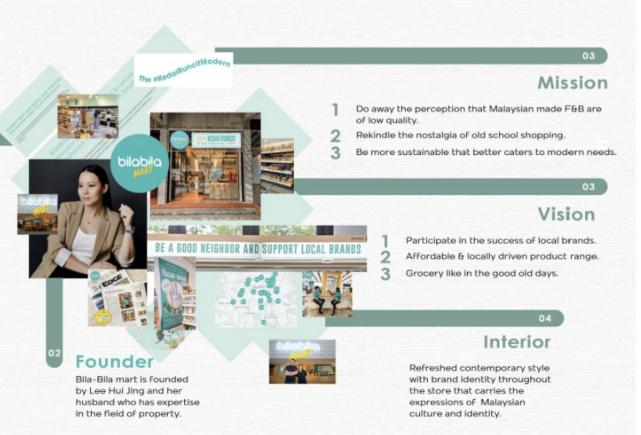

CONCEPT Aimed to recreate a sense of nostalgla and valued moments of traditional marketplace into the store, the interior captures and nods to the elements of traditional market scene such as maze of alleyways/ aisles, street booths. A VISIT TO A REIMAGINED canopies, as well as marketplace structures. Flaunting an TRADITIONAL MARKETPLACE array of textures, materials and light in each space.

THE MARKETPLACE TIES

EXPLORATION




Sense of being together as one with a crowd, even in the abscence of a relationship between each individual.

CAPTURING THE PULSE AND TEXTURE OF TRADITIONAL MARKETPLACE

Reintepreting the elements of traditional marketplace to the visualization of design.





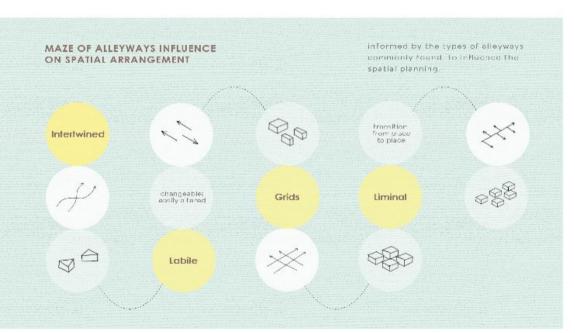





SCALE 1:75

PROGRAM OUTLINE



Low Waste Grocery Store

Refillery without unnecessary packaging.



Zero-Waste Cooking Class

Providing cooking recipes using ingredients you can buy in bulks, use across several monts, recipes that won't require obscure ingredients that you might not use again.



Compost & Bio-enzyme Workshop

Making compost & big-enzyme using left over fruit and veggie scraps after the zero-weste cooking class.



Veggie Garden

Growing several types of local veggles in-house. The nutrient-dense compost enriches soil and promotes veggle plant growth.



Smoothie Bar & Bakery

Providing an opportunity for grocers to use item in baked goods, singothies, fruit and vegetable trays before they go bad.

LEGEND

- 1. ENTRANCE
- 2. LOW WASTE GROCERY STORE
- 3. READY-TO-GO
- 4. OUTDOOR DINING
- 5. SMOOTHIE BAR & BAKERY
- 6. DINING AREA
- 7. TOILET
- 8. VEGGIE GARDEN
- 9. DISHWASHING & COMPOST ROOM
- 10. STAFF AREA

LOCKER & BREAK OUT AREA SECURITY ROOM

STORE ROOM

11. M&E ROOM



GROUND FLOOR PLAN





LEGEND

- 12. VEGGIE SEED STALL
- 13. ZERO WASTE COOKING CLASS
- 14. DINING AREA
- 15. MERCH BOOTHS
- 16. LEPAK AREA
- 17. BALCONY
- 18. COMPOST & BIO-ENZYME WORKSHOP
- 19. LINK BRIDGE
- 20. STORAGE
- 21. TOILET

SPACE PERCENTAGE





















SPACE CONNECTIVITY



SPACE LISTING

Customer Area

- 1. Low Waste Grocery Store
 2. Zero Waste Cooking Class
 3. Compost to Enzyme Workshop
 4. Veggle Garden
 5. Smoothle Bar & Bakery
 6. Restroom

Staff Area

- 1. Cashler
 2. Storage Area
 3. Stock Room
 4. Security Room
 5. Kitchen
 6. Unloading Area

DESIGN STRATEGY















FACADE

The facade feature took its design due from the textures found in marketplace canopy structures, gives form to the overhead storefront design.

















These suspended wooden from structures are a modern update of the traditional element of marketpace carapies. Lined along the stall aboths with customised aw light source high ighting the goods underneath, mimics the traditional marketplace scene.

Every element interprets a quality of the traditional marketplace, together forming a dynamic marketplace environment.









Smoothle Bar


A veggle garden is integrated into the

& Bakery

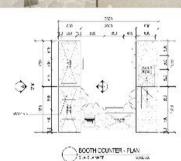



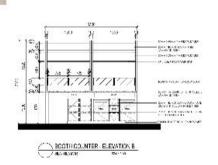

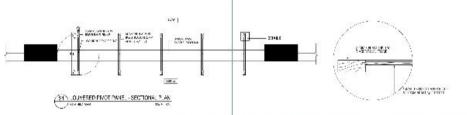











Large Space Open Air Promotes natural lighting, natural ventilation and allows cross-ventilation.



Sustalnable Operation Market sustained lifty activities, green operations. Reduce carbon outprints by having own veggle or aduction.

Veggie Garden

low waste grocery store lies a veggle garden at the back.

With a lower celling, the Former compresses views of the latter, capturing the curlous minds and attracts passer by to explore inside of the store.











The interior compines greenery with natural materials forge a greater connection to the outdoors, adds to the space a sense of interior-exterior ambience, suptly contains the identity of traditional marketplace.







Veggie Seed Stall



Marketplace Stall





A workshop that educates customer about food waste, learn about simple and easy ways to upcycle their organic waste by making a composter/











PREPARED BY: CHIATZE SHWEN (18026609)